


- SITE PLAN KEY NOTES:
- 1 NOT USED
 - 2 NOT USED
 - 3 NOT USED
 - 4 PRECAST CONCRETE PANEL SCREEN WALL
 - 5 EXISTING ELECTRICAL EQUIPMENT
 - 6 DUMPSTERS & RECYCLING CARTS (BY GOV'T)
 - 7 NOT USED
 - 8 NOT USED
 - 9 STONE STEP - SEE DETAIL 5D/5.17
 - 10 1200 [4'-0"] WIDE SIDEWALK WITH CONTROL JOINTS AT 1200 [4'-0"] O.C. SEE SHEET L1.1 FOR DIMENSIONS.
 - 11 NOT USED
 - 12 SITE LIGHTING - SEE ELECTRICAL. FIELD VERIFY EXACT LOCATION W/ ARCHITECT

- GENERAL NOTES:
- REFER TO CIVIL DRAWINGS FOR SITE, DEMOLITION, GRADING, SITE UTILITIES, AND SITE DIMENSIONS.
 - REFER TO LANDSCAPE PLAN FOR LANDSCAPE DESIGN.
 - REFER TO ELECTRICAL PLANS FOR SITE ELECTRICAL WORK.
 - REFER TO CIVIL AND LANDSCAPE DRAWINGS FOR SITE WORK BID OPTIONS

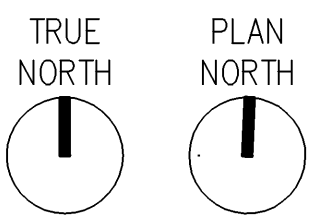

10 5 0 10 20


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ALL SCALES SHOWN ARE BASED ON A STANDARD DRAWING SIZE OF 28" X 40" OR METRIC DRAWING SIZE OF 841mm X 594mm. IF ANY OTHER SIZE DRAWINGS ARE FURNISHED OR PLOTTED THE CONTRACTOR SHALL ADJUST THE SCALES ACCORDINGLY. THE CONTRACTOR SHALL ALSO ADVISE HIS SUB-CONTRACTORS OF THE ABOVE.


I hereby certify this drawing was prepared by me or under my direct supervision and that I am a duly registered architect under the laws of the State of Minnesota.

For: Architectural Alliance
By: Title: Principal
Registration No: 16854


Revisions			
Symbol	Descriptions	Date	Approved
Architect: ARCHITECTURAL ALLIANCE MINNEAPOLIS, MINNESOTA		Engineer: MEAD & HUNT MADISON, WISCONSIN	U.S. ARMY ENGINEER DISTRICT CORPS OF ENGINEERS OMAHA, NEBRASKA
Designed by:	MINNEAPOLIS-ST. PAUL AFR MINNESOTA		
Drawn by: JM	CONSOLIDATED LODGING FACILITY - PHASE FOUR - PHASE FOUR SITE PLAN		
Checked by: EO			
Reviewed by: EO			
Submitted by:	Plot Scale Ratio: 1:1 Design File: 9941a13.dwg Spec. No.: W9128F-04-B-0002 Contract No.: W9128F-04-C-XXXX	Date: DECEMBER 2003 Drawing Code: AF 721-315-04	Sheet reference number: A1.3

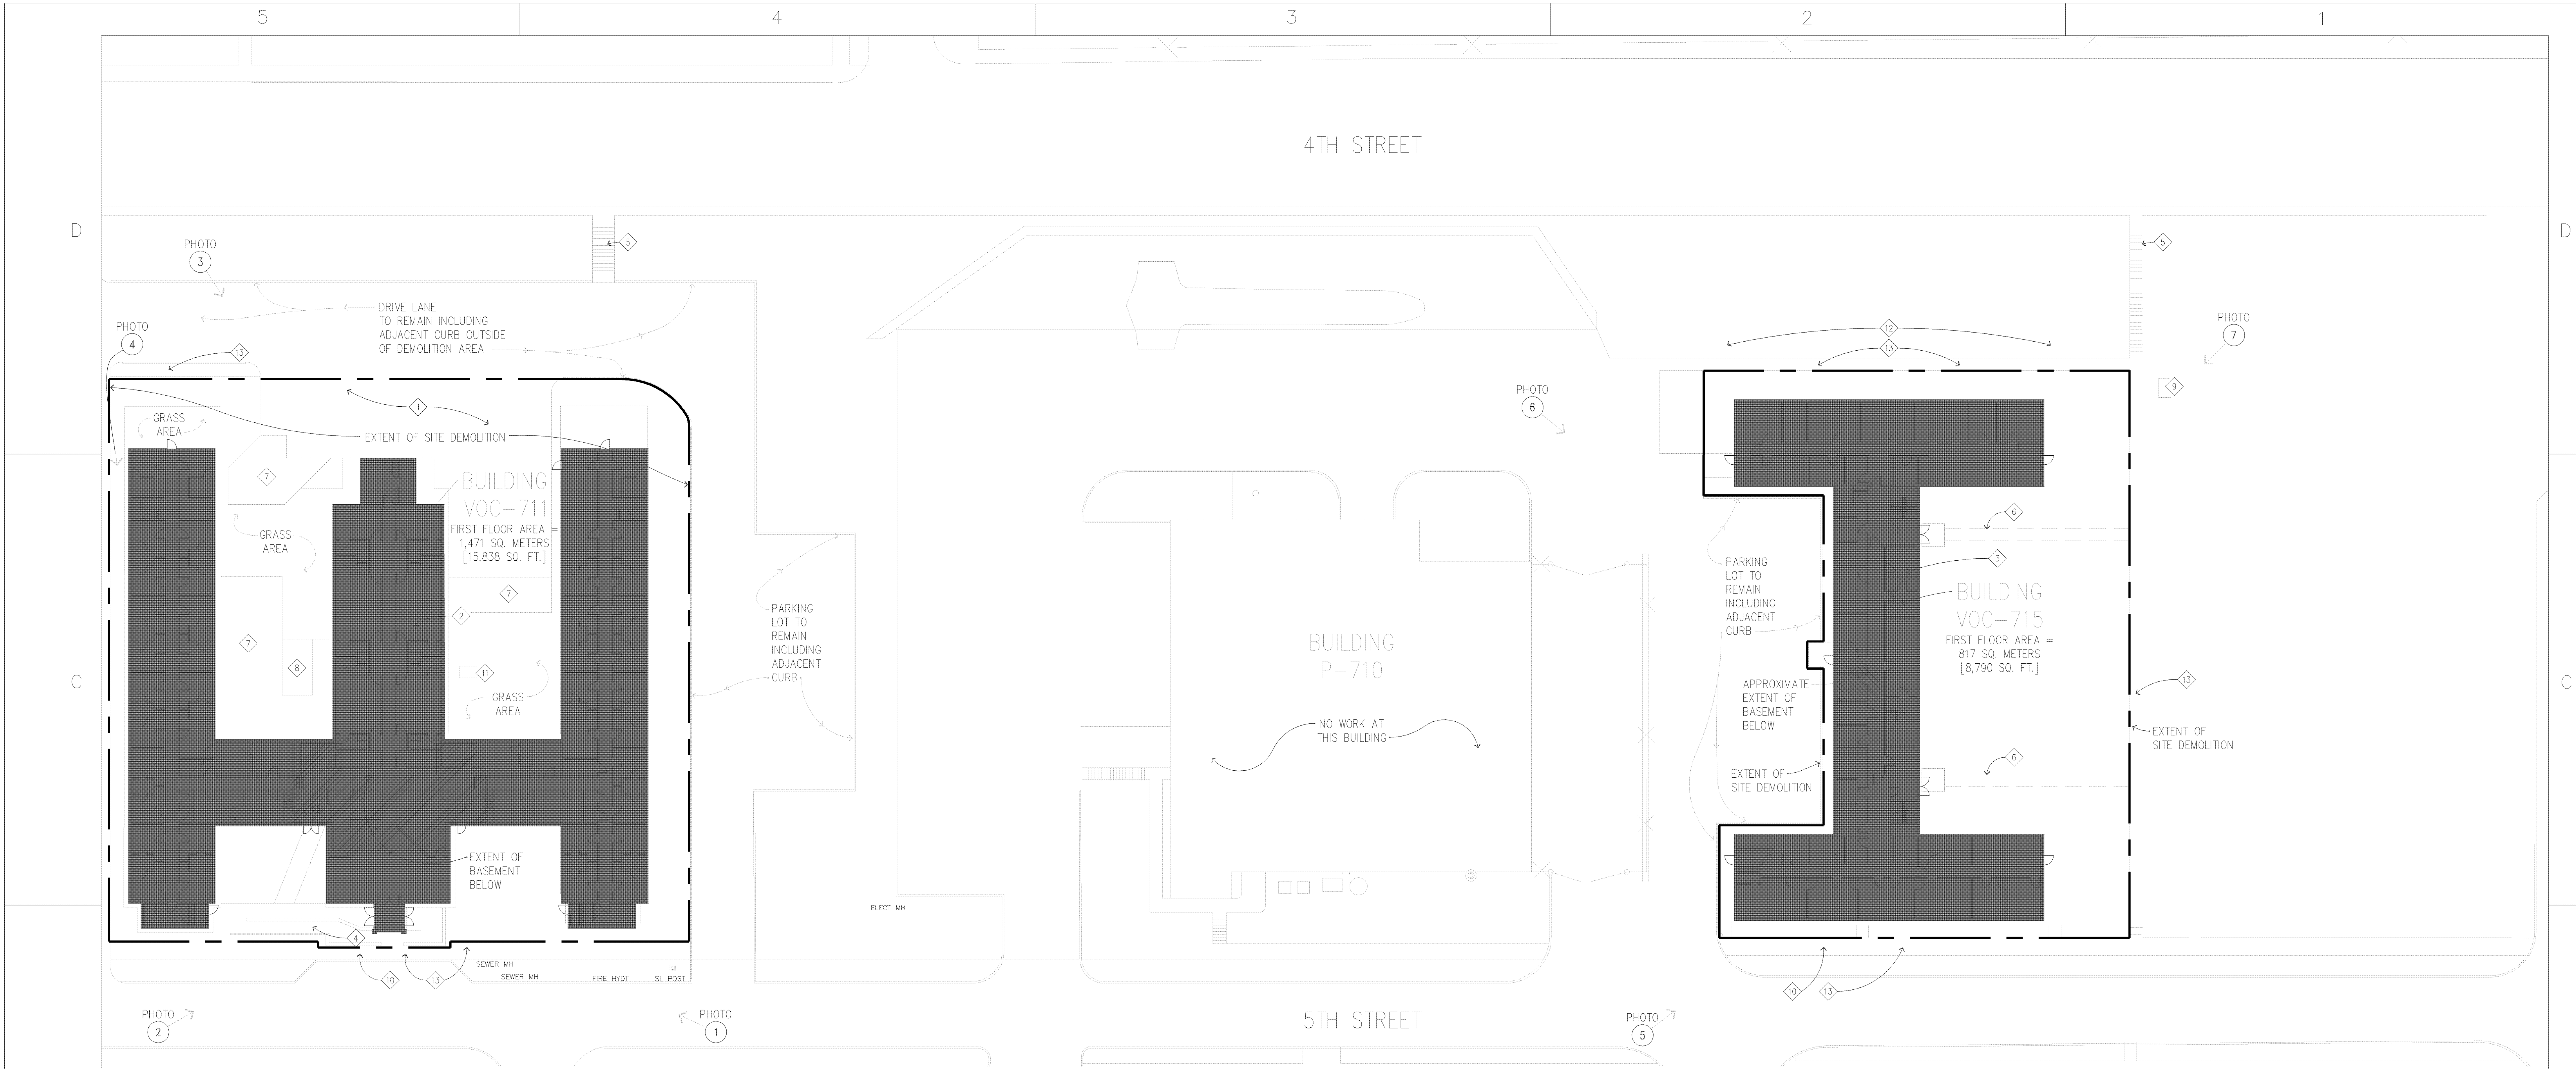

5B DEMOLITION PLAN
1:250

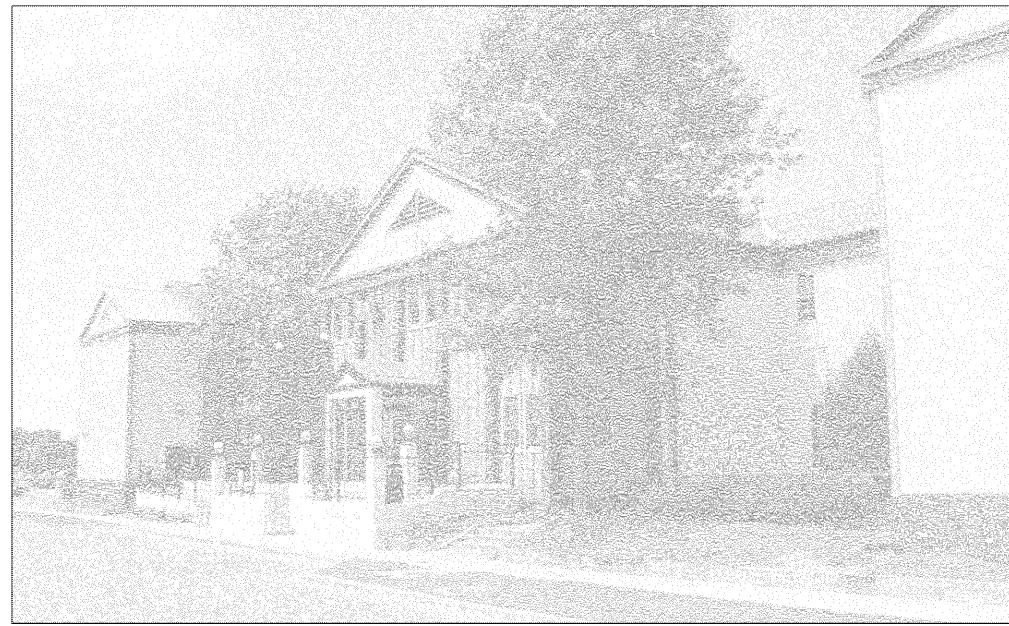


1 FRONT ENTRANCE TO BUILDING VOC-711, VIEWED FROM SOUTHEAST ON 5TH STREET.

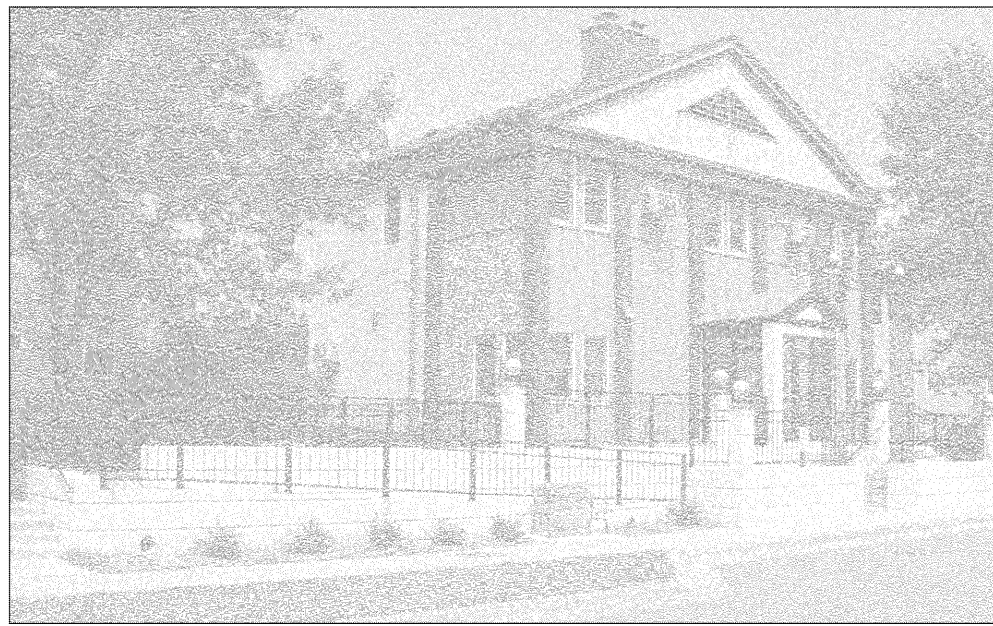

2 FRONT ENTRANCE TO BUILDING VOC-711, VIEWED FROM SOUTHWEST. CONCRETE RAMP AT ENTRANCE TO BE REMOVED.



3 BLDG. VOC-711, WEST SIDE

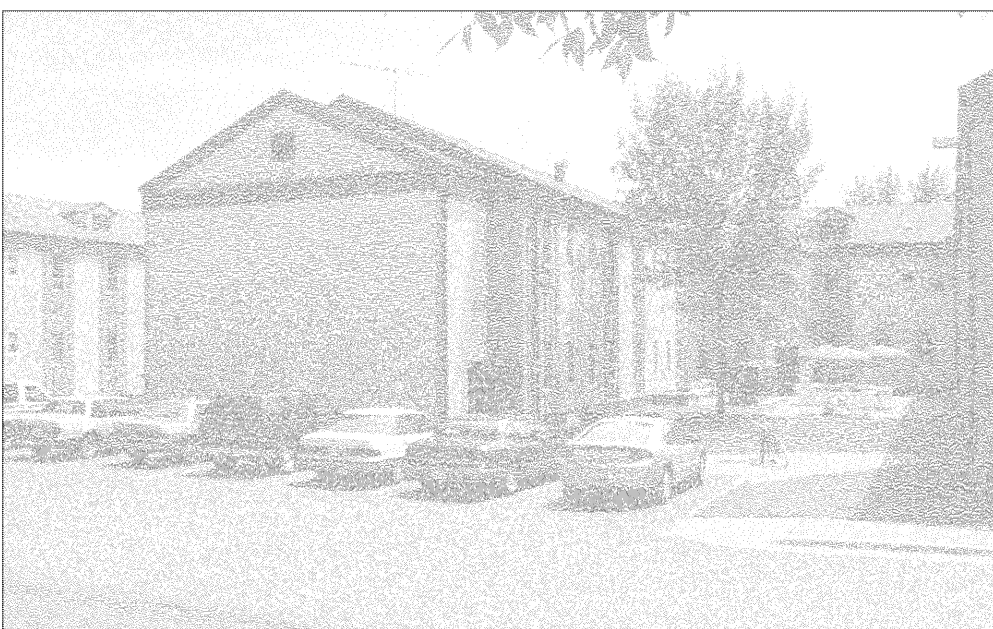

4 NORTH SIDE OF BUILDING VOC-711 SHOWING COURTYARDS.

Key Notes

1. THE FOLLOWING IS PROVIDED FOR GENERAL INFORMATION ONLY. GENERAL CONTRACTOR IS RESPONSIBLE FOR VISITING SITE TO VERIFY EXISTING CONDITIONS AND SCOPE OF WORK REQUIRED FOR DEMOLITION.
2. REMOVE PARKING LOT AND RELATED CURB & GUTTER.
3. BUILDING VOC 711: TWO STORY, WOOD FRAMED STRUCTURE WITH GABLED ROOF AND PARTIAL BASEMENT. FOUNDATION SYSTEM CONSISTS OF POURED CONCRETE PIERS WHICH EXTEND FROM CONCRETE PAD FOOTINGS FOUR FEET BELOW GRADE TO SUPPORT THE ELEVATED WOOD FRAMED FIRST FLOOR (VERIFY ACTUAL HEIGHTS). BETWEEN PIERS, INFILL WALLS ARE WOOD FRAMED. AT THE PARTIAL BASEMENT, PERIMETER WALLS ARE POURED CONCRETE WITH INTERIOR STEEL PIPE COLUMNS SUPPORTING THE FIRST FLOOR. THE BUILDING COMPONENTS MAY CONTAIN ASBESTOS. SEE SPECIFICATIONS FOR ABATEMENT PROCEDURES.
4. BUILDING VOC 715: TWO STORY, WOOD FRAMED STRUCTURE WITH GABLED ROOF AND PARTIAL BASEMENT AT ORIGINAL MECHANICAL ROOM. FOUNDATION SYSTEM CONSISTS OF POURED CONCRETE PIERS WHICH EXTEND FROM CONCRETE PAD FOOTINGS FOUR FEET BELOW GRADE TO SUPPORT THE ELEVATED WOOD FRAMED FIRST FLOOR (VERIFY ACTUAL HEIGHTS). BETWEEN PIERS, FOUNDATION INFILL WALLS ARE WOOD FRAMED. AT THE PARTIAL BASEMENT (APPROXIMATELY 3454 mm x 4267 mm [11'-4" x 14'-0"] VERIFY). WALLS ARE 203 mm [8"] THICK POURED CONCRETE ON STRIP FOOTINGS WITH CONCRETE SLAB ON GRADE FLOOR. MANY OF THE BUILDING COMPONENTS CONTAIN ASBESTOS. SEE SPECIFICATIONS FOR ABATEMENT PROCEDURES.
5. REMOVE ENTRANCE CANOPY AND RAMP. PROTECT EXIST. UTILITY TUNNEL UNDER ADJACENT SIDEWALK FROM DAMAGE DURING DEMOLITION. REPAIR ANY DAMAGE TO EXIST. UTILITY TUNNEL THAT MAY OCCUR DURING DEMOLITION, RESTORING IT TO CONDITION BEFORE RAMP DEMOLITION. STAIRS TO REMAIN.
6. REMOVE SIDEWALK. RE-GRADE AS NEEDED AND SEED AREA WITH TURF SEED.
7. REMOVE CONCRETE PAVING. RE-GRADE AS NEEDED AND SEED AREA WITH TURF SEED.
8. REMOVE EQUIPMENT AND CONCRETE PAD. RE-GRADE AS NEEDED AND SEED AREA WITH TURF SEED.
9. EQUIPMENT AND CONCRETE PAD TO REMAIN. PROTECT FROM DAMAGE DURING DEMOLITION.
10. EXISTING UTILITY TUNNEL UNDER SIDEWALK TO REMAIN. PROTECT FROM DAMAGE DURING DEMOLITION.
11. SEE ELECTRICAL NOTE 1. TRANSFORMER TO BE REMOVED BY GOV'T. REMOVE CONCRETE PAD.
12. DURING DEMOLITION, PROTECT EXISTING UNDERGROUND ELECTRICAL PRIMARY FROM DAMAGE. PRIMARY IS LOCATED JUST NORTH OF AND PARALLEL TO THE SIDEWALK TO REMAIN.
13. SIDEWALK TO REMAIN.



5 BUILDING VOC-715, VIEWED FROM SOUTHWEST



6 BUILDING VOC-715, VIEWED FROM NORTHWEST SHOWING COURTYARDS.




7 BUILDING VOC-715, VIEWED FROM NORTHEAST NOTE ELECTRICAL EQUIPMENT (BOX IN FOREGROUND) TO REMAIN

General Notes

1. SHADED AREAS INDICATE BUILDINGS TO BE DEMOLISHED.
2. CONTRACTOR SHALL REMOVE ALL EXISTING BUILDINGS AND RELATED CONSTRUCTION INDICATED TO BE DEMOLISHED INCLUDING FOOTINGS, FOUNDATION WALLS AND UTILITY LINES.
3. ALL EXISTING UTILITY LINES SERVING BUILDINGS (WATER, SANITARY, STORM, POWER) SHALL BE REMOVED BACK TO THE MAINS AND CAPPED. GAS LINES SHALL BE REMOVED BACK TO THE METER; CONTACT MINNEGASCO PRIOR TO COMPLETION OF REMOVAL. ALL ABANDONED UTILITY PIPING, CONDUIT AND BOXES ARE TO BE REMOVED. COORDINATE ALL UTILITY WORK WITH GOVERNMENT.
4. REMOVE ALL EXISTING FOUNDATION WALLS AND FOOTINGS.
5. REMOVE CONCRETE SLABS ON GRADE.
6. REMOVE UNDERGROUND TANKS, COMPONENTS, AND PIPING FROM SITE.
7. KEEP WORK SPRINKLED TO MINIMIZE DUST. PROVIDE HOSES AND WATERMAIN OR HYDRANT CONNECTIONS FOR THIS PURPOSE.
8. BACKFILL AREAS EXCAVATED, OPEN PITS AND HOLES CAUSED AS A RESULT OF DEMOLITION. USE SUBSOIL SPECIFIED IN SECTION 02200. PROVIDE MIN. 4" TOPSOIL.
9. ROUGH GRADE AND COMPACT AREAS AFFECTED BY DEMOLITION TO MAINTAIN SITE GRADES AND CONTOURS. SEED GRADED AREAS WITH TURF SEED.
10. REMOVE DEMOLISHED MATERIALS FROM SITE AS WORK PROGRESSES. LEAVE SITE IN CLEAN CONDITION.
11. REFER TO SPECIFICATIONS FOR SPECIFIC REQUIREMENTS AND GUIDELINES FOR ASBESTOS ABATEMENT, DECONSTRUCTION PROCEDURES, AND RECYCLING.

Electrical Note

1. GOVERNMENT SHALL DISCONNECT AND REMOVE EXISTING SERVICE TRANSFORMER. CONTRACTOR SHALL DISCONNECT AND REMOVE EXISTING SECONDARY SERVICE LATERAL FROM EXISTING SERVICE TRANSFORMER TO BUILDING 711. CONTRACTOR SHALL REMOVE EXISTING PRIMARY FEEDER AND ASSOCIATED MANHOLE BACK TO MAIN DISTRIBUTION LINE. SEE DRAWING 01-4.2 - UTILITY DEMOLITION. CONTRACTOR SHALL VERIFY EXACT REQUIREMENTS AND COORDINATE ANY ASSOCIATED SERVICE OUTAGE WITH THE GOVERNMENT.

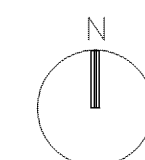


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Revisions			
Symbol	Descriptions	Date	Approved
Architect: ARCHITECTURAL ALLIANCE MINNEAPOLIS, MINNESOTA		Engineer: MEAD & HUNT MADISON, WISCONSIN	U.S. ARMY ENGINEER DISTRICT CORPS OF ENGINEERS OMAHA, NEBRASKA
Designed by: JM		MINNEAPOLIS-ST. PAUL AFR MINNESOTA	
Drawn by: JM		CONSOLIDATED LODGING FACILITY - PHASE FOUR - DEMOLITION	
Checked by: EO			
Reviewed by: EO		Plot Scale Ratio: 1:1 Design File: 9941a14.dwg	Date: DECEMBER 2003
Submitted by:		Spec. No.: W9128F-04-B-0002 Contract No.: W9128F-04-C-XXXX	Drawing Code: AF 721-315-04
			Sheet reference number: A1.4


I hereby certify this drawing was prepared by me or under my direct supervision and that I am a duly registered architect under the laws of the State of Minnesota.

For: Architectural Alliance
By: Title: Principal
Registration No: 16854



5B CODE ANALYSIS PLAN - ALL PHASES
1:200

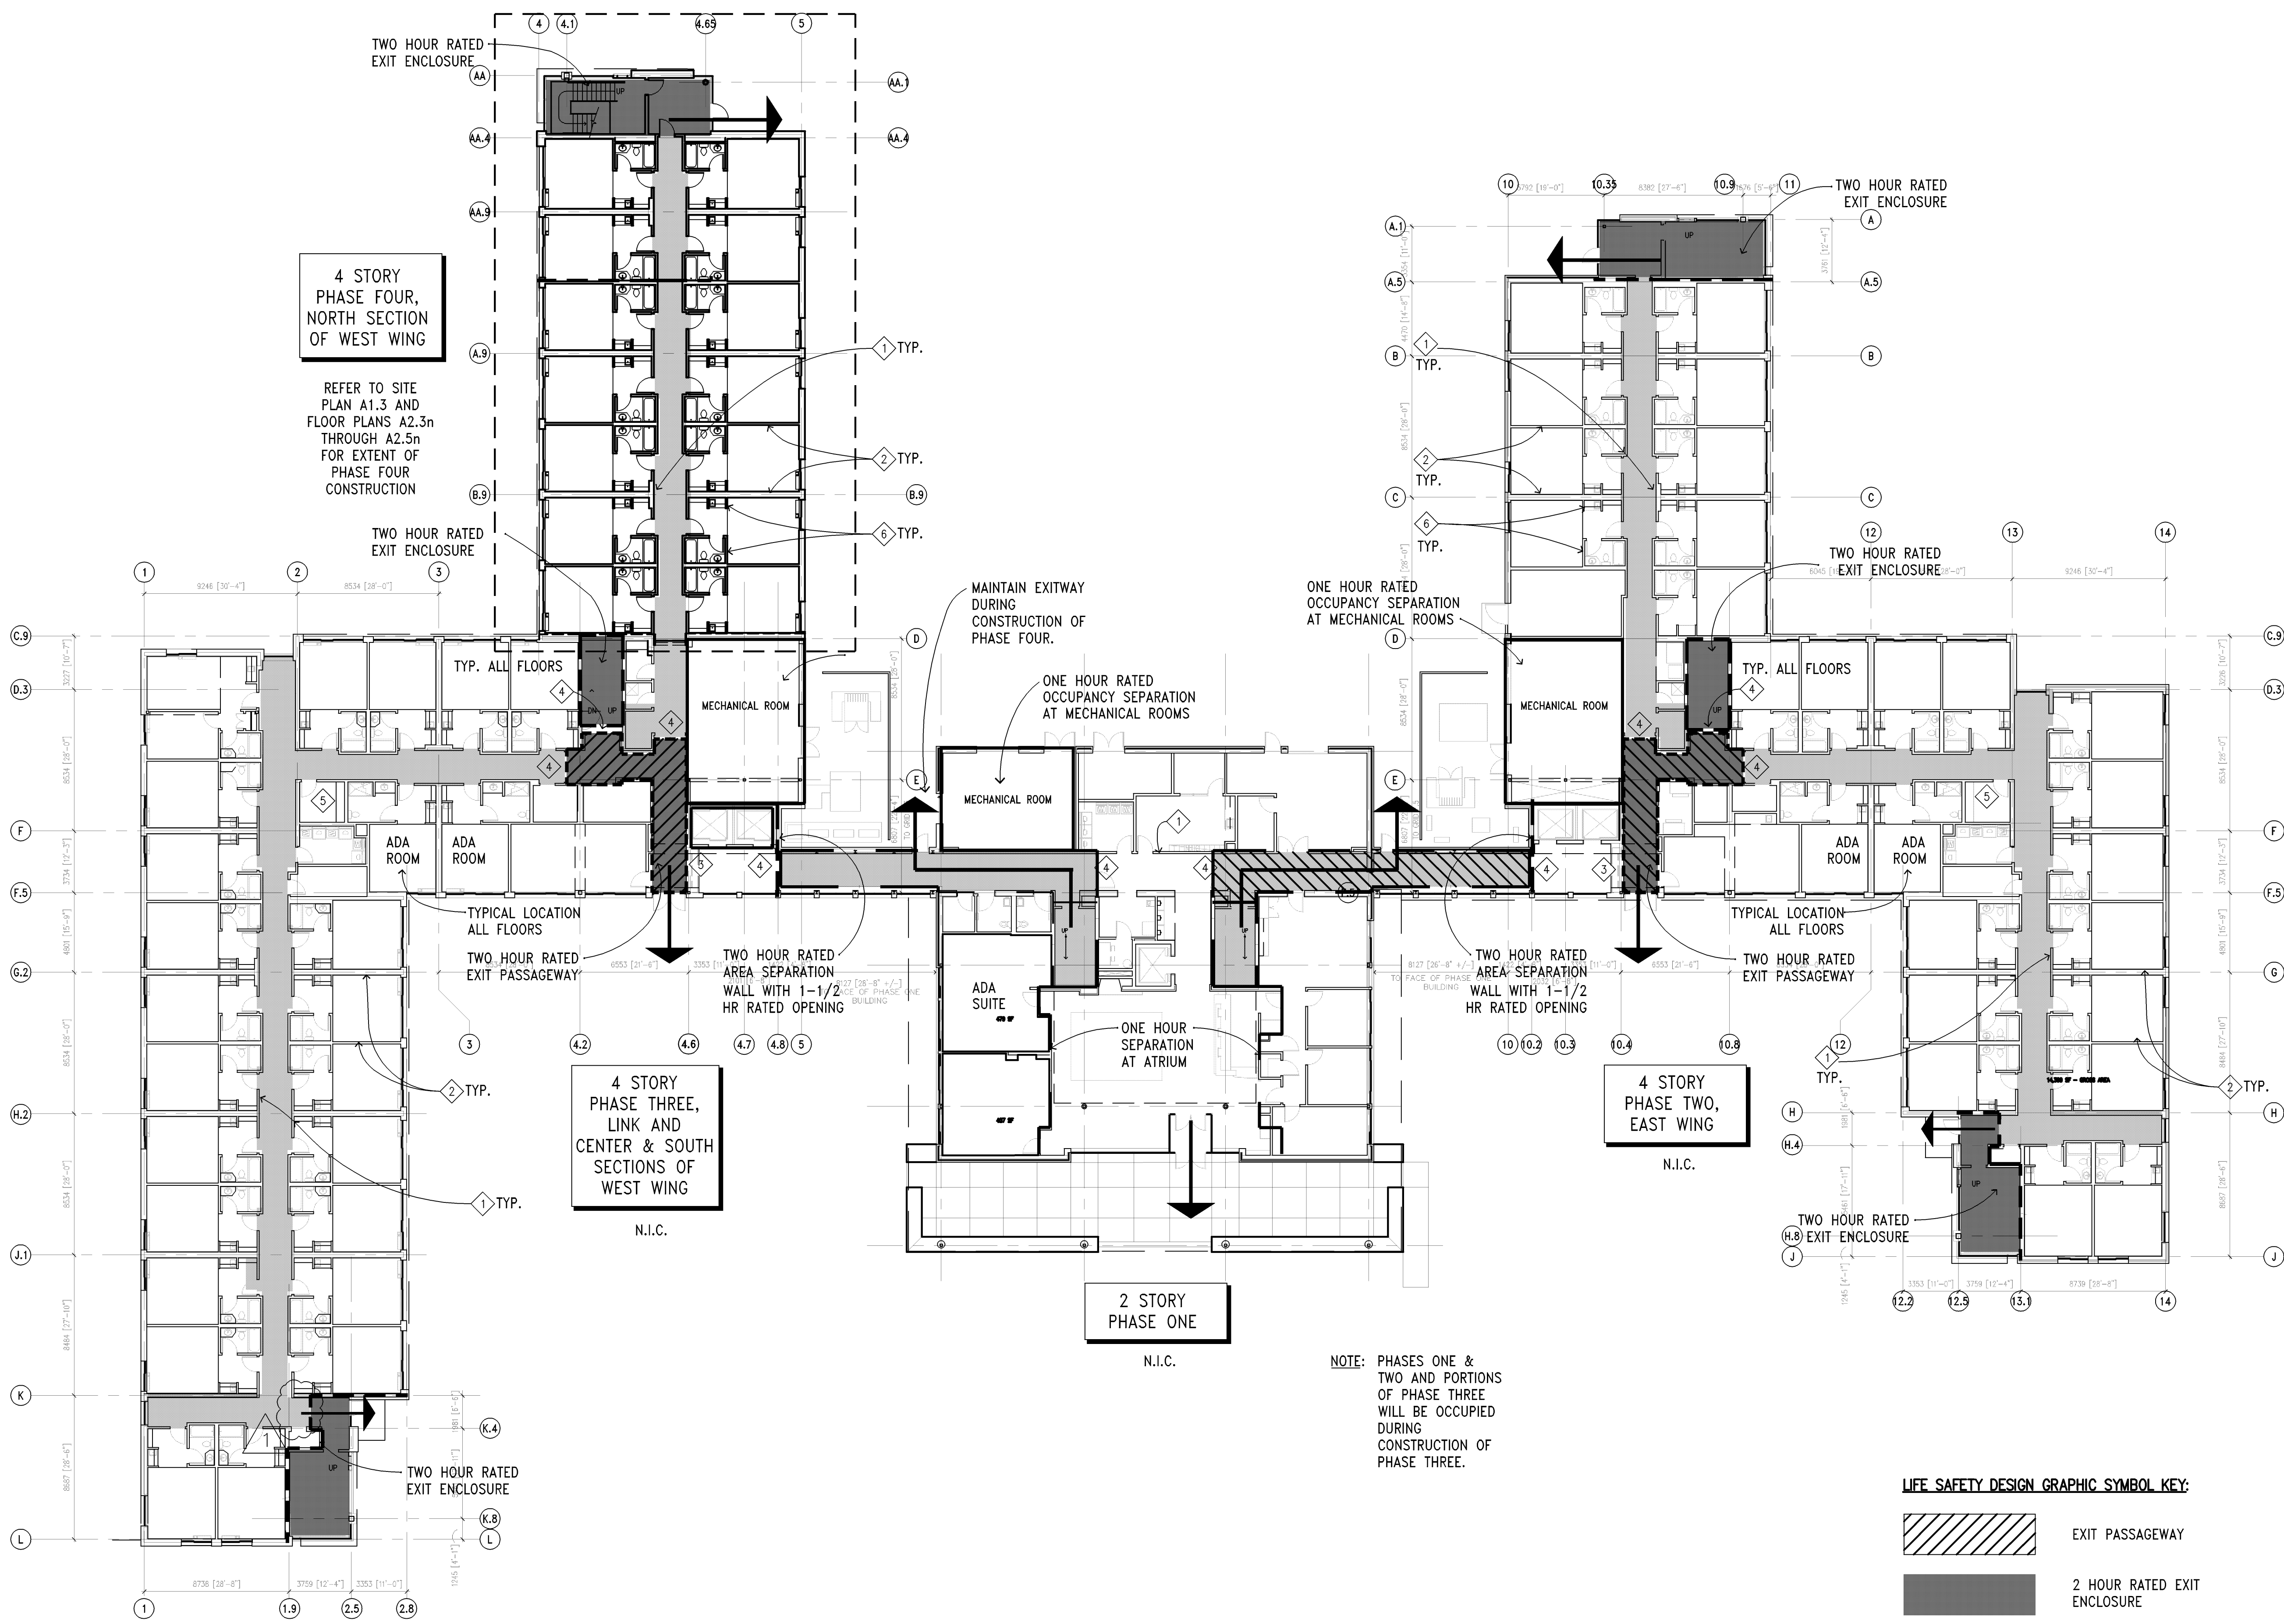LIFE SAFETY DESIGN GRAPHIC SYMBOL KEY:

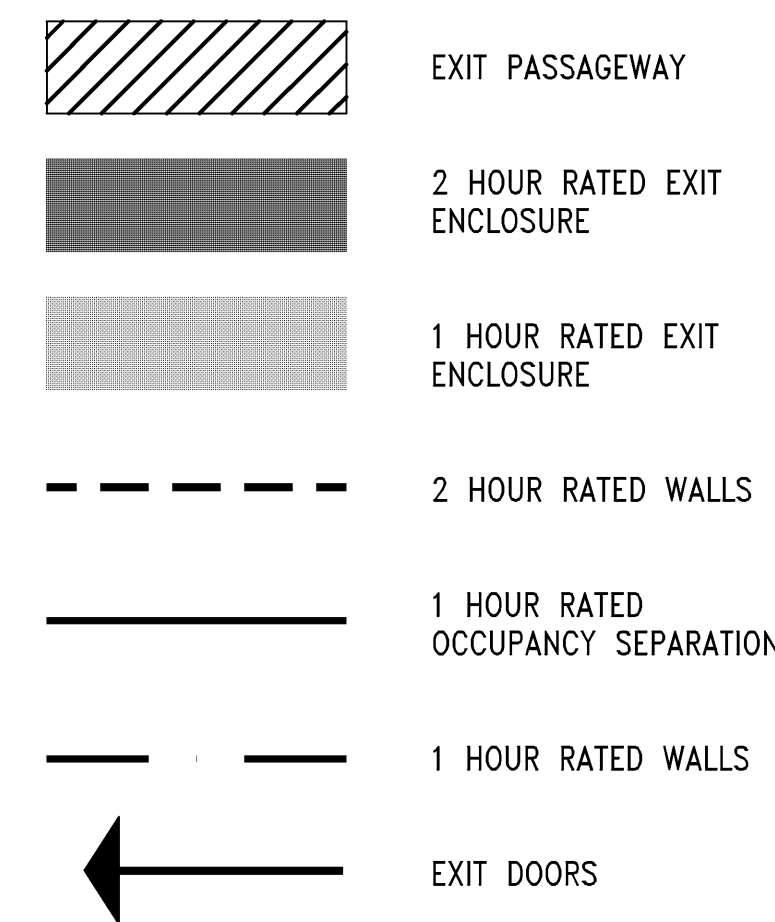

LIFE SAFETY DESIGN KEY NOTES:


- ONE HOUR RATED PARTITIONS WITH 20 MINUTE RATED DOOR ASSEMBLIES TYPICAL FOR ALL FLOORS.
- ONE HOUR RATED PARTITIONS TYPICAL FOR ALL COMMON WALLS BETWEEN GUEST ROOMS.
- FIRE SHUTTER TO SEPARATE ELEVATOR LOBBY (1-1/2 HR. RATED).
- FIRE RATED DOORS ON MAGNETIC HOLD-OPENS TIED TO FIRE ALARM SYSTEM (1-1/2 HR. RATED).
- LAUNDRY, STORAGE, ELECTRICAL ROOM PARTITIONS ARE TO BE ONE HOUR RATED WITH 20 MINUTE DOOR ASSEMBLIES.
- PARTITIONS TOTALLY CONTAINED WITHIN GUEST ROOMS MAY BE NON-RATED.

ADA COMPLIANCE:

- EXTERIOR ACCESSIBLE ROUTES ARE DESIGNED TO CONNECT SIDEWALKS, ACCESSIBLE PARKING AND ALL BUILDING ENTRANCES.
- ALL FLOORS, PUBLIC SPACES AND CIRCULATION ROUTES ARE DESIGNED TO MEET ADA ACCESSIBILITY REQUIREMENTS.
- ACCESSIBLE ROOMS ARE DESIGNATED ON EACH FLOOR.
- MECHANICAL, ELECTRICAL, STORAGE, AND RECEIVING AREA ROOMS ARE CLASSIFIED BY ADA AS WORK AREAS.
- AN ACCESSIBLE PUBLIC PAY TELEPHONE IS DESIGNED TO BE INSTALLED IN PHASE ONE.

APPLICABLE LIFE SAFETY CODE INFORMATION:

- BUILDING TO COMPLY WITH NFPA-1997 REQUIREMENTS.
- OCCUPANCY TYPE: RESIDENTIAL (UBC GROUP R, DIVISION 1)
- CONSTRUCTION TYPE: TYPE II - ONE HOUR
- HAZARD CLASSIFICATION: ORDINARY HAZARD
- FIRE-RESISTIVE REQUIREMENTS FOR BUILDING COMPONENTS:
 - BEARING WALLS - EXTERIOR 1 HOUR
 - BEARING WALLS - INTERIOR 1 HOUR
 - NON-BEARING WALLS - EXTERIOR 0 HOURS
 - STRUCTURAL FRAME 1 HOUR
 - PARTITIONS - PERMANENT 1 HOUR
 - SHAFT ENCLOSURES 1 HOUR
 - FLOORS AND FLOOR-CEILINGS 1 HOUR
 - ROOFS AND ROOF-CEILINGS 1 HOUR
 - EXTERIOR DOORS AND WINDOWS 0 HOURS

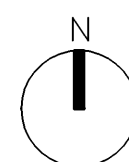

I hereby certify this drawing was prepared by me or under my direct supervision and that I am a duly registered architect under the laws of the State of Minnesota.

For: Architectural Alliance
By: Title: Principal
Registration No: 16854

8 4 0 8 16
SCALE: 1 : 200

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Revisions			
Symbol	Descriptions	Date	Approved
Architect:		Engineer:	U.S. ARMY ENGINEER DISTRICT
ARCHITECTURAL ALLIANCE MINNEAPOLIS, MINNESOTA		MEAD & HUNT MADISON, WISCONSIN	CORPS OF ENGINEERS OMAHA, NEBRASKA
Designed by:		MINNEAPOLIS-ST. PAUL AFR MINNESOTA	
Drawn by:		CONSOLIDATED LODGING FACILITY — PHASE FOUR — LIFE SAFETY DESIGN	
JM			
Checked by:			
EO			
Reviewed by:		Plot Scale Ratio: 1:1	Sheet
EO		Design File: 9941a20.dwg	reference
Submitted by:		Spec. No.: W9128F-04-B-0002	number:
		Contract No.: W9128F-04-C-XXXX	
		Drawing Code: AF 721-315-04	A2,0




1. REFER TO CIVIL DRAWINGS FOR SITE DEMOLITION, GRADING, SITE UTILITIES, AND SITE DIMENSIONS.
2. REFER TO LANDSCAPE PLAN FOR LANDSCAPE DESIGN.
3. REFER TO ELECTRICAL PLANS FOR SITE ELECTRICAL WORK.
4. SEE SHEET A8.6 FOR DOOR SCHEDULE AND FINISH SCHEDULE
5. SEE SHEET A8.10 FOR WALL TYPES

- 1 NOT USED
- 2 PROVIDE CORNER GUARDS AT ALL OUTSIDE CORNERS ON CORRIDOR WALLS ONLY
- 3 PHASE ONE EXIT PASSAGE TO BE MAINTAINED AND PROTECTED FOR DURATION OF CONSTRUCTION ACTIVITY
- 4 ALL DIMENSIONS ARE NOTED IN BOTH METRIC (mm) AND STANDARD UNITS.
- 5 ALL DRAWINGS ARE PLOTTED TO THE METRIC SCALES INDICATED ON THE DRAWINGS
- 6 UTILIZE WORKPOINT AT EXISTING BUILDING INTERSECTION FOR LAYOUT OF GRIDLINES
- 7 FEC – MOUNT AT 54" FROM FLOOR TO TOP OF ROUGH OPENING
- 8 ONE HOUR FIRE RATED WALL RECESS FOR ELECTRICAL PANEL
- 9 11'-1 1/8" x 3'-4" RECESSED MAT; FIELD VERIFY SIZE – SEE DETAIL 4A/A5.20
- 10 NOT USED
- 11 FIBER-REINFORCED GYPSUM COLUMN COVER, 300 [1'-0"] DIA.
- 12 EXPANSION JOINT COVERS, FLOOR AND WALLS
- 13 REMOVE EXISTING EXTERIOR INSULATION & FINISH SYSTEM (EIFS) BACK TO EXISTING CMU STRUCTURAL WALL
- 14 REMOVE EXISTING CURTAIN WALL SYSTEM AND SUPPORTS BACK TO THE EXISTING STRUCTURAL FLOOR EDGE
- 15 REMOVE EXISTING COMPOSITE METAL PANEL SYSTEM BACK TO THE EXISTING CMU STRUCTURAL WALL AT AREAS CONNECTING TO PHASE 4



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Revisions				
Symbol	Descriptions		Date	Approved
Architect:	Engineer:			
ARCHITECTURAL ALLIANCE MINNEAPOLIS, MINNESOTA	MEAD & HUNT MADISON, WISCONSIN		U.S. ARMY ENGINEER DISTRICT CORPS OF ENGINEERS OMAHA, NEBRASKA	
Designed by: SS	MINNEAPOLIS—ST. PAUL AFR		MINNESOTA	
Drawn by: JM	CONSOLIDATED LODGING FACILITY — PHASE FOUR — FIRST FLOOR PLAN			
Checked by: EO				
Reviewed by: EO	Plot Scale Ratio: 1:1	Date: DECEMBER 2003	Sheet reference number:	
Submitted by:	Design File: 9941a23n.dwg		Drawing Code:	
	Spec. No.: W9128F-04-B-0002		AF 721-315-04	
	Contract No.: W9128F-04-C-XXXX		A2.3n	

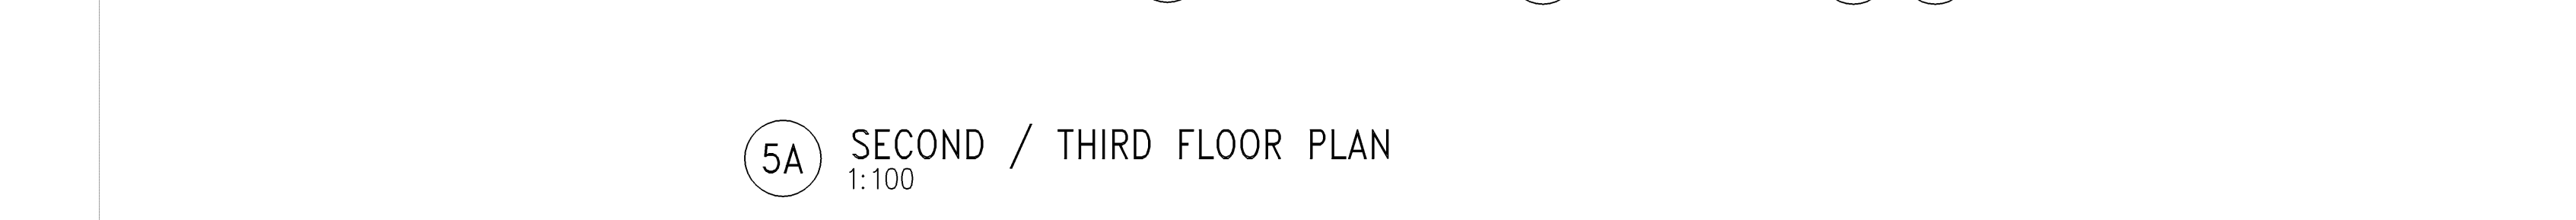

1. SEE SHEET A8.6 FOR DOOR SCHEDULE AND FINISH SCHEDULE
2. SEE SHEET A8.10 FOR WALL TYPES

- ① NOT USED
- ② PROVIDE CORNER GUARDS AT ALL OUTSIDE CORNERS ON CORRIDOR WALLS ONLY
- ③ ROOM NUMBERS SHOWN ARE FOR SECOND FLOOR (2XXX). THIRD FLOOR ROOM NUMBERS ARE SIMILAR BUT BEGIN WITH 3 (3XXX).
- ④ ALL DIMENSIONS ARE NOTED IN BOTH METRIC (MM) AND STANDARD UNITS.
- ⑤ ALL DRAWINGS ARE PLOTTED TO THE METRIC SCALES INDICATED ON THE DRAWINGS
- ⑥ UTILIZE WORK POINT AT EXISTING BUILDING INTERSECTION FOR LAYOUT OF GRIDLINES
- ⑦ FEC – MOUNT AT 54" FROM FLOOR TO TOP OF ROUGH OPENING
- ⑧ ONE HOUR FIRE RATED WALL RECESS FOR ELECTRICAL PANEL
- ⑨ NOT USED
- ⑩ NOT USED
- ⑪ FIBER-REINFORCED GYPSUM COLUMN COVER, 300 [1'-0"] DIA.
- ⑫ EXPANSION JOINT COVERS, FLOOR AND WALLS
- ⑬ REMOVE EXISTING EXTERIOR INSULATION & FINISH SYSTEM (EIFS) BACK TO EXISTING CMU STRUCTURAL WALL
- ⑭ REMOVE EXISTING CURTAIN WALL SYSTEM AND SUPPORTS BACK TO THE EXISTING STRUCTURAL FLOOR EDGE.
- ⑮ REMOVE EXISTING COMPOSITE METAL PANEL SYSTEM BACK TO THE EXISTING CMU STRUCTURAL WALL AT AREAS CONNECTING TO PHASE 4



I hereby certify this drawing was prepared by me or under my direct supervision and that I am a duly registered architect under the laws of the State of Minnesota.


For: Architectural Alliance
By:
Title: Principal
Registration No: 16854

SCALE: 1 : 100


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Revisions			
Symbol	Descriptions	Date	Approved

Architect:	ARCHITECTURAL ALLIANCE MINNEAPOLIS, MINNESOTA		Engineer:	MEAD & HUNT MADISON, WISCONSIN		U.S. ARMY ENGINEER DISTRICT CORPS OF ENGINEERS OMAHA, NEBRASKA
Designed by:	SS		MINNEAPOLIS—ST. PAUL AFR			MINNESOTA
Drawn by:	JM		CONSOLIDATED LODGING FACILITY — PHASE FOUR —			
Checked by:	EO		SECOND/THIRD FLOOR PLAN			
Reviewed by:	EO		Plot Scale Ratio:	Date:	Sheet reference:	
Submitted by:			Design File: 9941a24n.dwg	DECEMBER 2003		
			Spec. No.: W9128F-04-B-0002	Drawing Code:		
			Contract No.: W9128F-04-B-0002	AF 721-315-04	A2.4n	

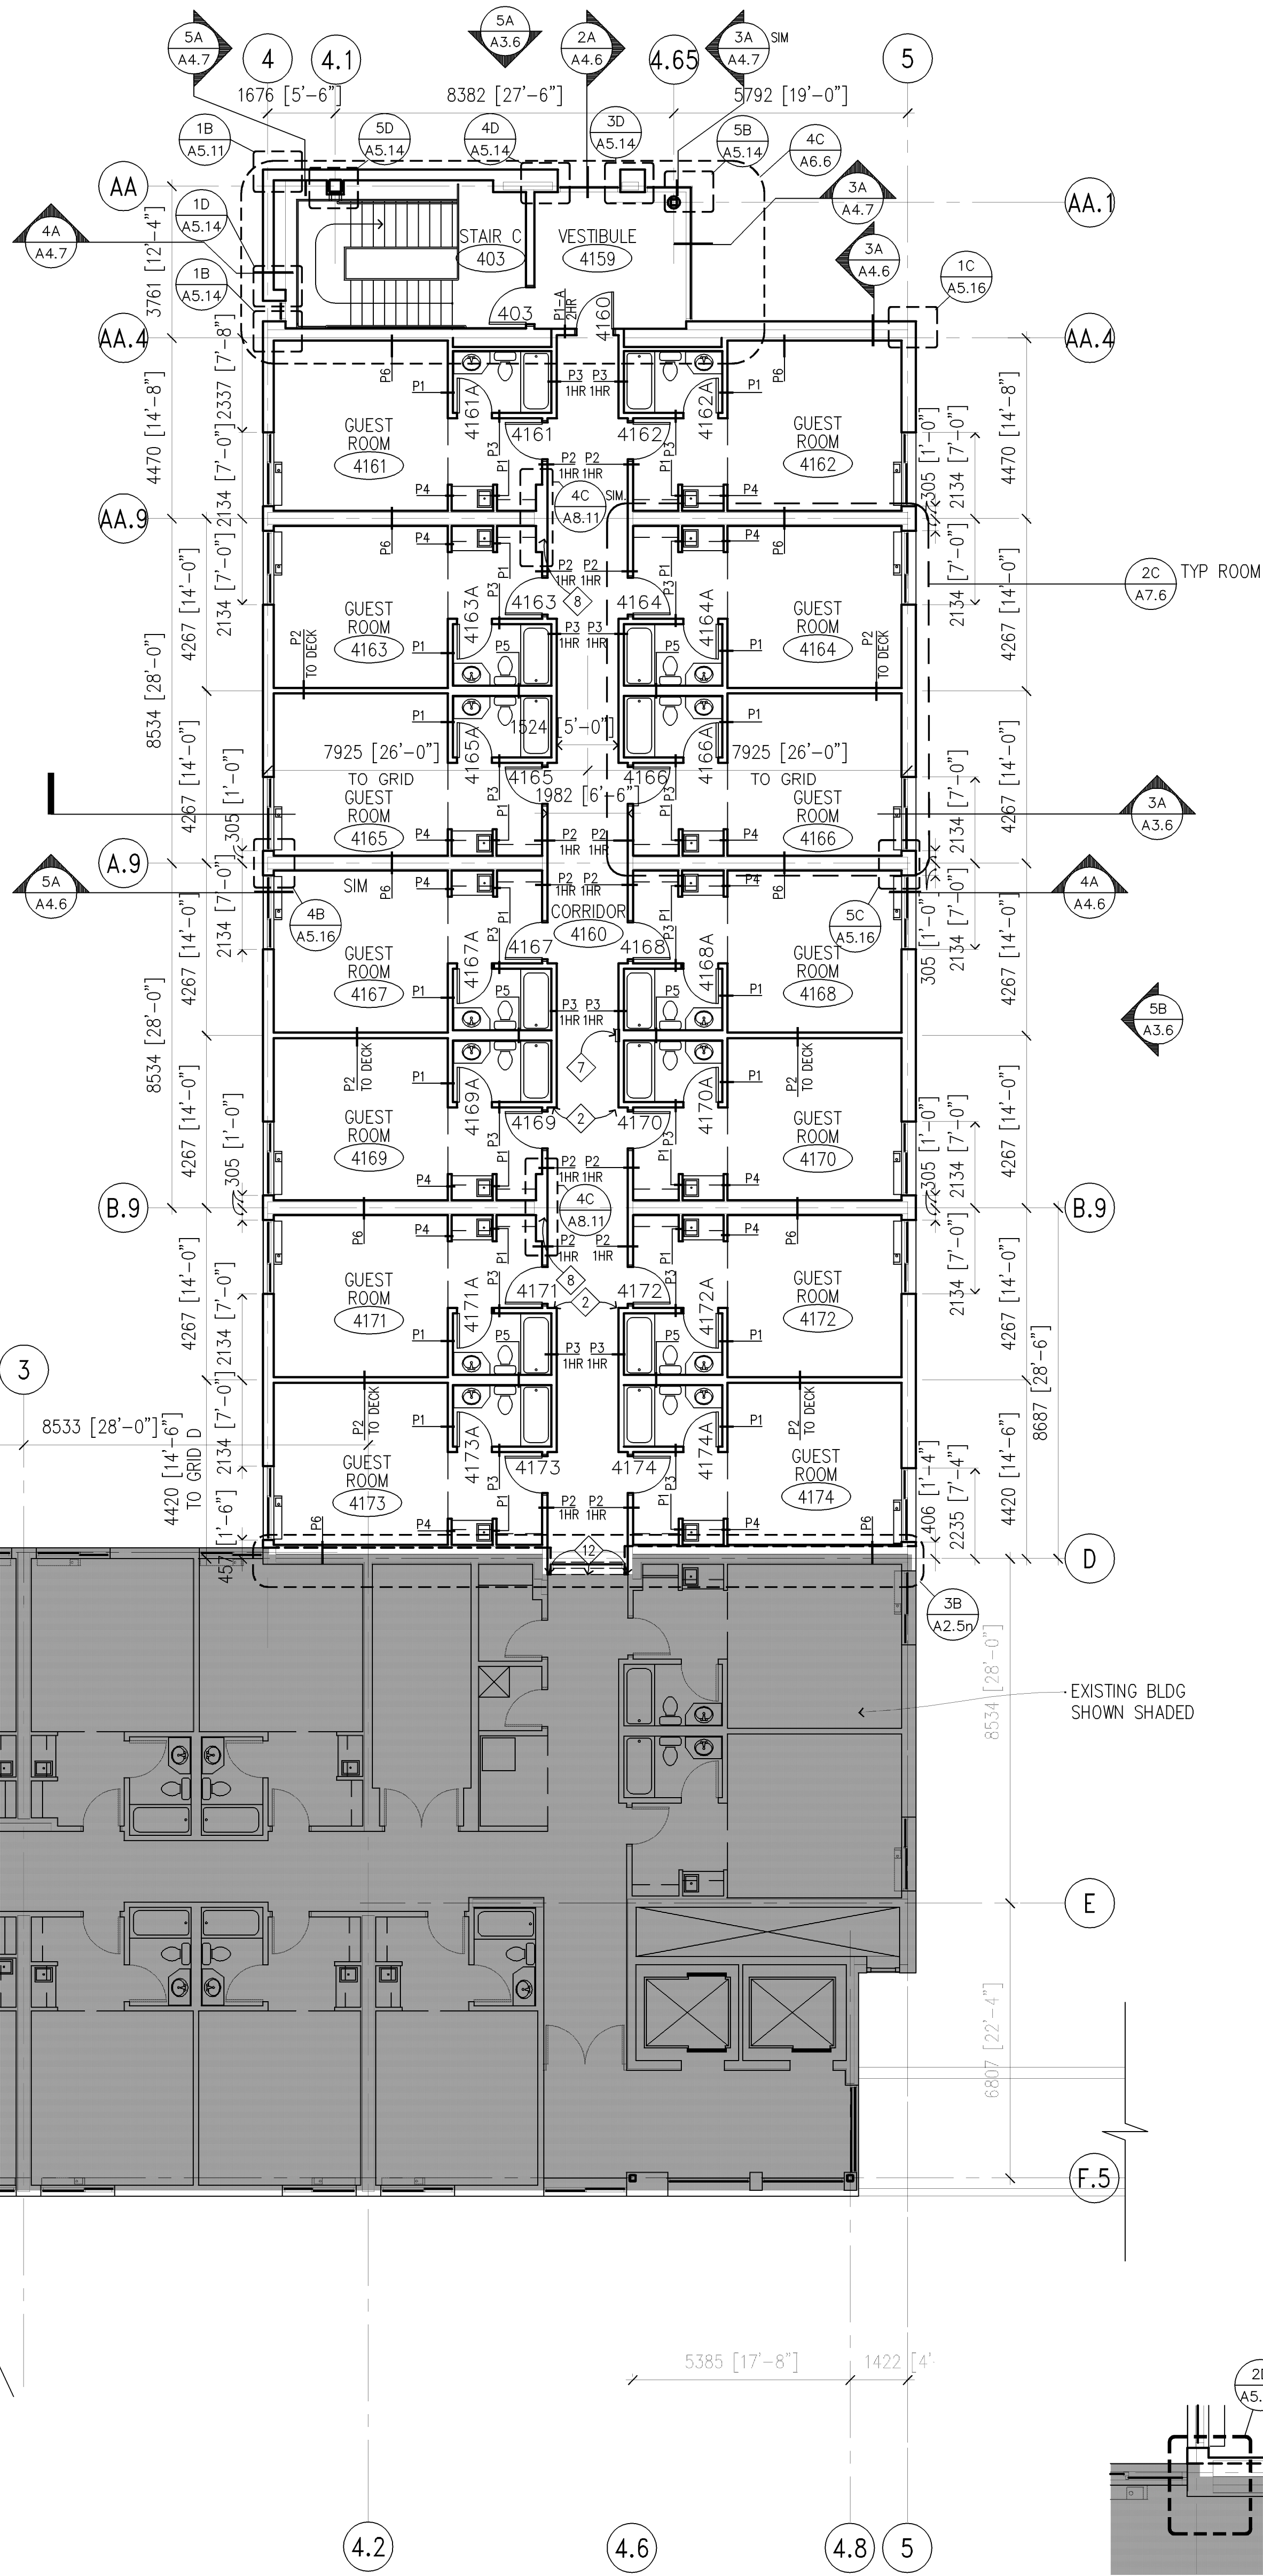

5A FOURTH FLOOR PLAN
1:100

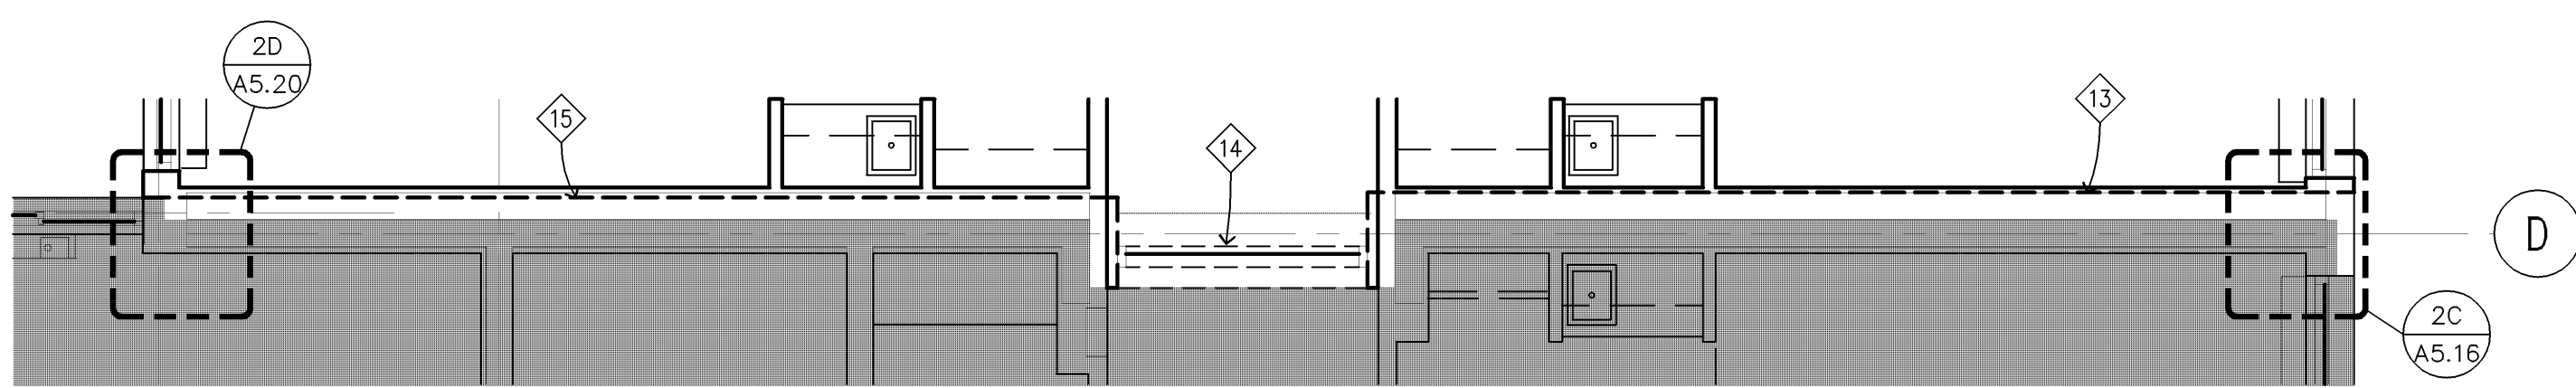


3A ENLARGED FOURTH FLOOR PLAN AT GRID 'D'
1:50

GENERAL NOTES:


1. SEE SHEET A8.6 FOR DOOR SCHEDULE AND FINISH SCHEDULE
2. SEE SHEET A8.10 FOR WALL TYPES

FOURTH FLOOR PLAN NOTES:

- 1 NOT USED
- 2 PROVIDE CORNER GUARDS AT ALL OUTSIDE CORNERS ON CORRIDOR WALLS ONLY
- 3 NOT USED
- 4 ALL DIMENSIONS ARE NOTED IN BOTH METRIC (mm) AND STANDARD UNITS.
- 5 ALL DRAWINGS ARE PLOTTED TO THE METRIC SCALES INDICATED ON THE DRAWINGS
- 6 UTILIZE WORKPOINT AT EXISTING BUILDING INTERSECTION FOR LAYOUT OF GRIDLINES
- 7 FEC - MOUNT AT 54" FROM FLOOR TO TOP OF ROUGH OPENING
- 8 ONE HOUR FIRE RATED WALL RECESS FOR ELECTRICAL PANEL
- 9 NOT USED
- 10 NOT USED
- 11 NOT USED
- 12 EXPANSION JOINT COVERS, FLOOR AND WALLS
- 13 REMOVE EXISTING EXTERIOR INSULATION & FINISH SYSTEM (EIFS) BACK TO EXISTING CMU STRUCTURAL WALL
- 14 REMOVE EXISTING CURTAIN WALL SYSTEM AND SUPPORTS BACK TO THE EXISTING STRUCTURAL FLOOR EDGE
- 15 REMOVE EXISTING METAL PANEL SYSTEM BACK TO THE EXISTING CMU STRUCTURAL WALL AT AREAS CONNECTING TO PHASE 4

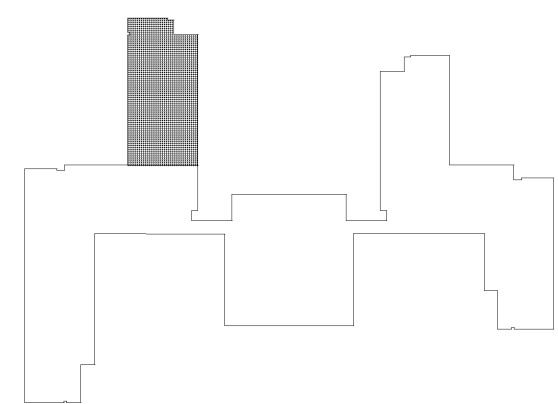

KEY PLAN

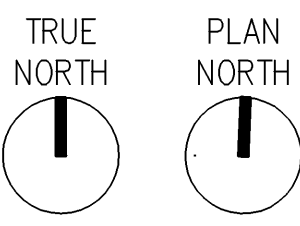

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For: Architectural Alliance
By: Title: Principal
Registration No: 16854

4000 2000 0 4000 8000

SCALE: 1 : 100

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ARCHITECTURAL ALLIANCE		MEAD & HUNT	CORPS OF ENGINEERS
MINNEAPOLIS, MINNESOTA		MADISON, WISCONSIN	OMAHA, NEBRASKA
Designed by:	MINNEAPOLIS-ST. PAUL AFR MINNESOTA		
SS	CONSOLIDATED LODGING FACILITY - PHASE FOUR - FOURTH FLOOR PLAN		
Drawn by:			
JM			
Checked by:			
EO			
Reviewed by:	Plot Scale Ratio:	Date:	Sheet
EO	Design File: 9941a25n.dwg	DECEMBER 2003	reference
Submitted by:	Spec. No.:	Drawing Code:	number:
	W9128F-04-B-0002	AF 721-315-04	A2.5n
Contract No.:		AF 721-315-04	
W9128F-04-C-XXXX		AF 721-315-04	

